

SHEET 14

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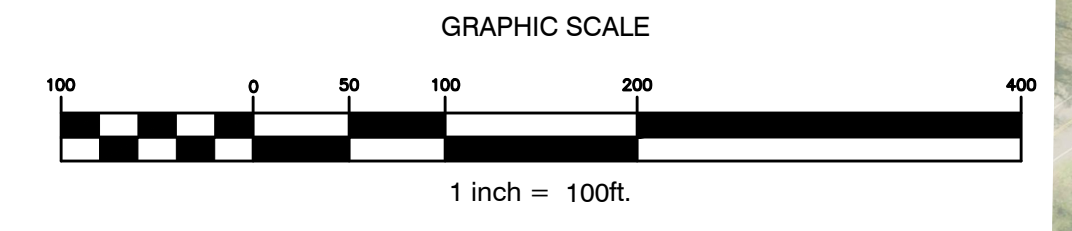
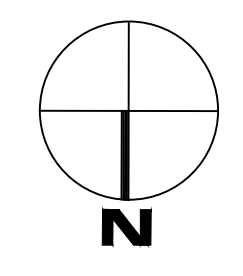
SHEET 13

SHEET 15

LEGEND

	STREAM		EDGE OF WATER
	EDGE OF PAVEMENT		BUILDING
	STORM DRAIN CULVERT NUMBER (HIGHEST, HIGH, MEDIUM, LOW)		CULVERT MODELED IN HYDROCAD (HIGHEST, HIGH, MEDIUM, LOW)
	STORM DRAIN SWALE NUMBER (HIGHEST, HIGH, MEDIUM, LOW)		SWALE MODELED IN HYDROCAD (HIGHEST, HIGH, MEDIUM, LOW)
	WATERSHED		SUB-CATCHMENT
	SWALE		STORM DRAIN CULVERT
	20' CONTOUR		TIME OF CONCENTRATION

- PLAN REFERENCES:**
- AERIAL PHOTO PROVIDED BY MAINE GIS DATABASE.
 - CULVERT AND SWALE LOCATIONS AND OTHER LINE WORK TAKEN FROM EXISTING CAD FILES PREPARED BY LAND USE CONSULTANTS OCTOBER 1994.
 - FOR DETAILED CULVERT AND SWALE INFORMATION REFER TO CONDITION OF DRAINAGE INFRASTRUCTURE CULVERT AND SWALE INVENTORIES.



SUGARLOAF MOUNTAIN WATERSHED ANALYSIS

PHASE IV
CARRABASSETT VALLEY, MAINE

TOWN OF CARRABASSETT VALLEY
101 CARRIAGE ROAD
CARRABASSETT VALLEY, ME 04947

Rev.	Date	Description	Drawn	Check
1	1/13/15	ISSUED TO TOWN	AANGC	WRW
2	01/17	ISSUED TO TOWN	TPJ/CAR	WRW
3	1/19	ISSUED TO TOWN	JWG	WRW

Sheet Title:
DRAINAGE PLAN SHEET 14

Job No.: 160DRN Sheet No.:
Date: 1-13-2015
Scale: 1"=100'
Drawn: TPJ
Checked: WRW

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