


**LEGEND**

- STREAM
- EDGE OF WATER
- EDGE OF PAVEMENT
- BUILDING
- STORM DRAIN CULVERT NUMBER (HIGHEST, HIGH, MEDIUM, LOW)
- CULVERT MODELED IN HYDROCAD (HIGHEST, HIGH, MEDIUM, LOW)
- STORM DRAIN SWALE NUMBER (HIGHEST, HIGH, MEDIUM, LOW)
- SWALE MODELED IN HYDROCAD (HIGHEST, HIGH, MEDIUM, LOW)
- WATERSHED
- SUB-CATCHMENT
- SWALE
- STORM DRAIN CULVERT
- 20' CONTOUR
- TIME OF CONCENTRATION

**PLAN REFERENCES:**

- AERIAL PHOTO PROVIDED BY MAINE GIS DATABASE.
- CULVERT AND SWALE LOCATIONS AND OTHER LINE WORK TAKEN FROM EXISTING CAD FILES PREPARED BY LAND USE CONSULTANTS OCTOBER 1994.
- FOR DETAILED CULVERT AND SWALE INFORMATION REFER TO CONDITION OF DRAINAGE INFRASTRUCTURE CULVERT AND SWALE INVENTORIES.

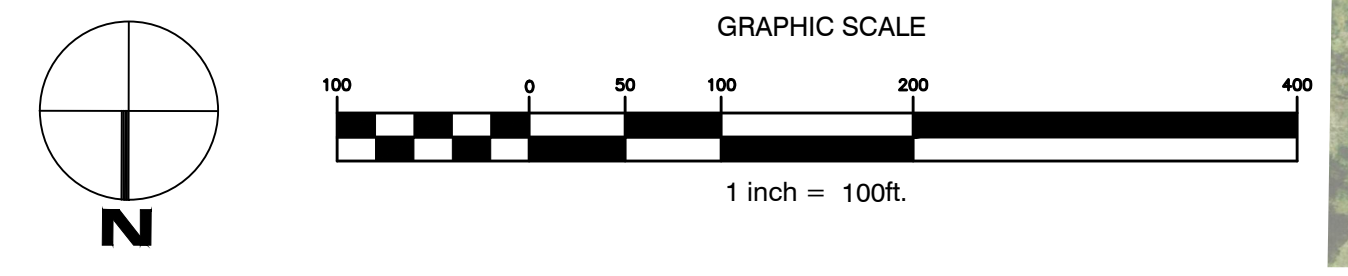

**SUGARLOAF MOUNTAIN WATERSHED ANALYSIS**  
PHASE IV  
CARRABASSETT VALLEY, MAINE  
**TOWN OF CARRABASSETT VALLEY**  
101 CARRIAGE ROAD  
CARRABASSETT VALLEY, ME 04947

Rev.	Date	Description	Drawn	Check
1	1/13/15	ISSUED TO TOWN	AA/NGC	WRW
2	6/11/17	ISSUED TO TOWN	TPJ/CAR	WRW
3	1/8/19	ISSUED TO TOWN	JWG	WRW

Sheet Title:  
**DRAINAGE PLAN SHEET 13**

Job No.: 160DRN Sheet No.:  
Date: 1-13-2015  
Scale: 1"=100'  
Drawn: TPJ  
Checked: WRW

**13**