


SUGARLOAF MOUNTAIN WATERSHED ANALYSIS

PHASE IV
CARRABASSETT VALLEY, MAINE

TOWN OF CARRABASSETT VALLEY


101 CARRIAGE ROAD
CARRABASSETT VALLEY, ME 04947

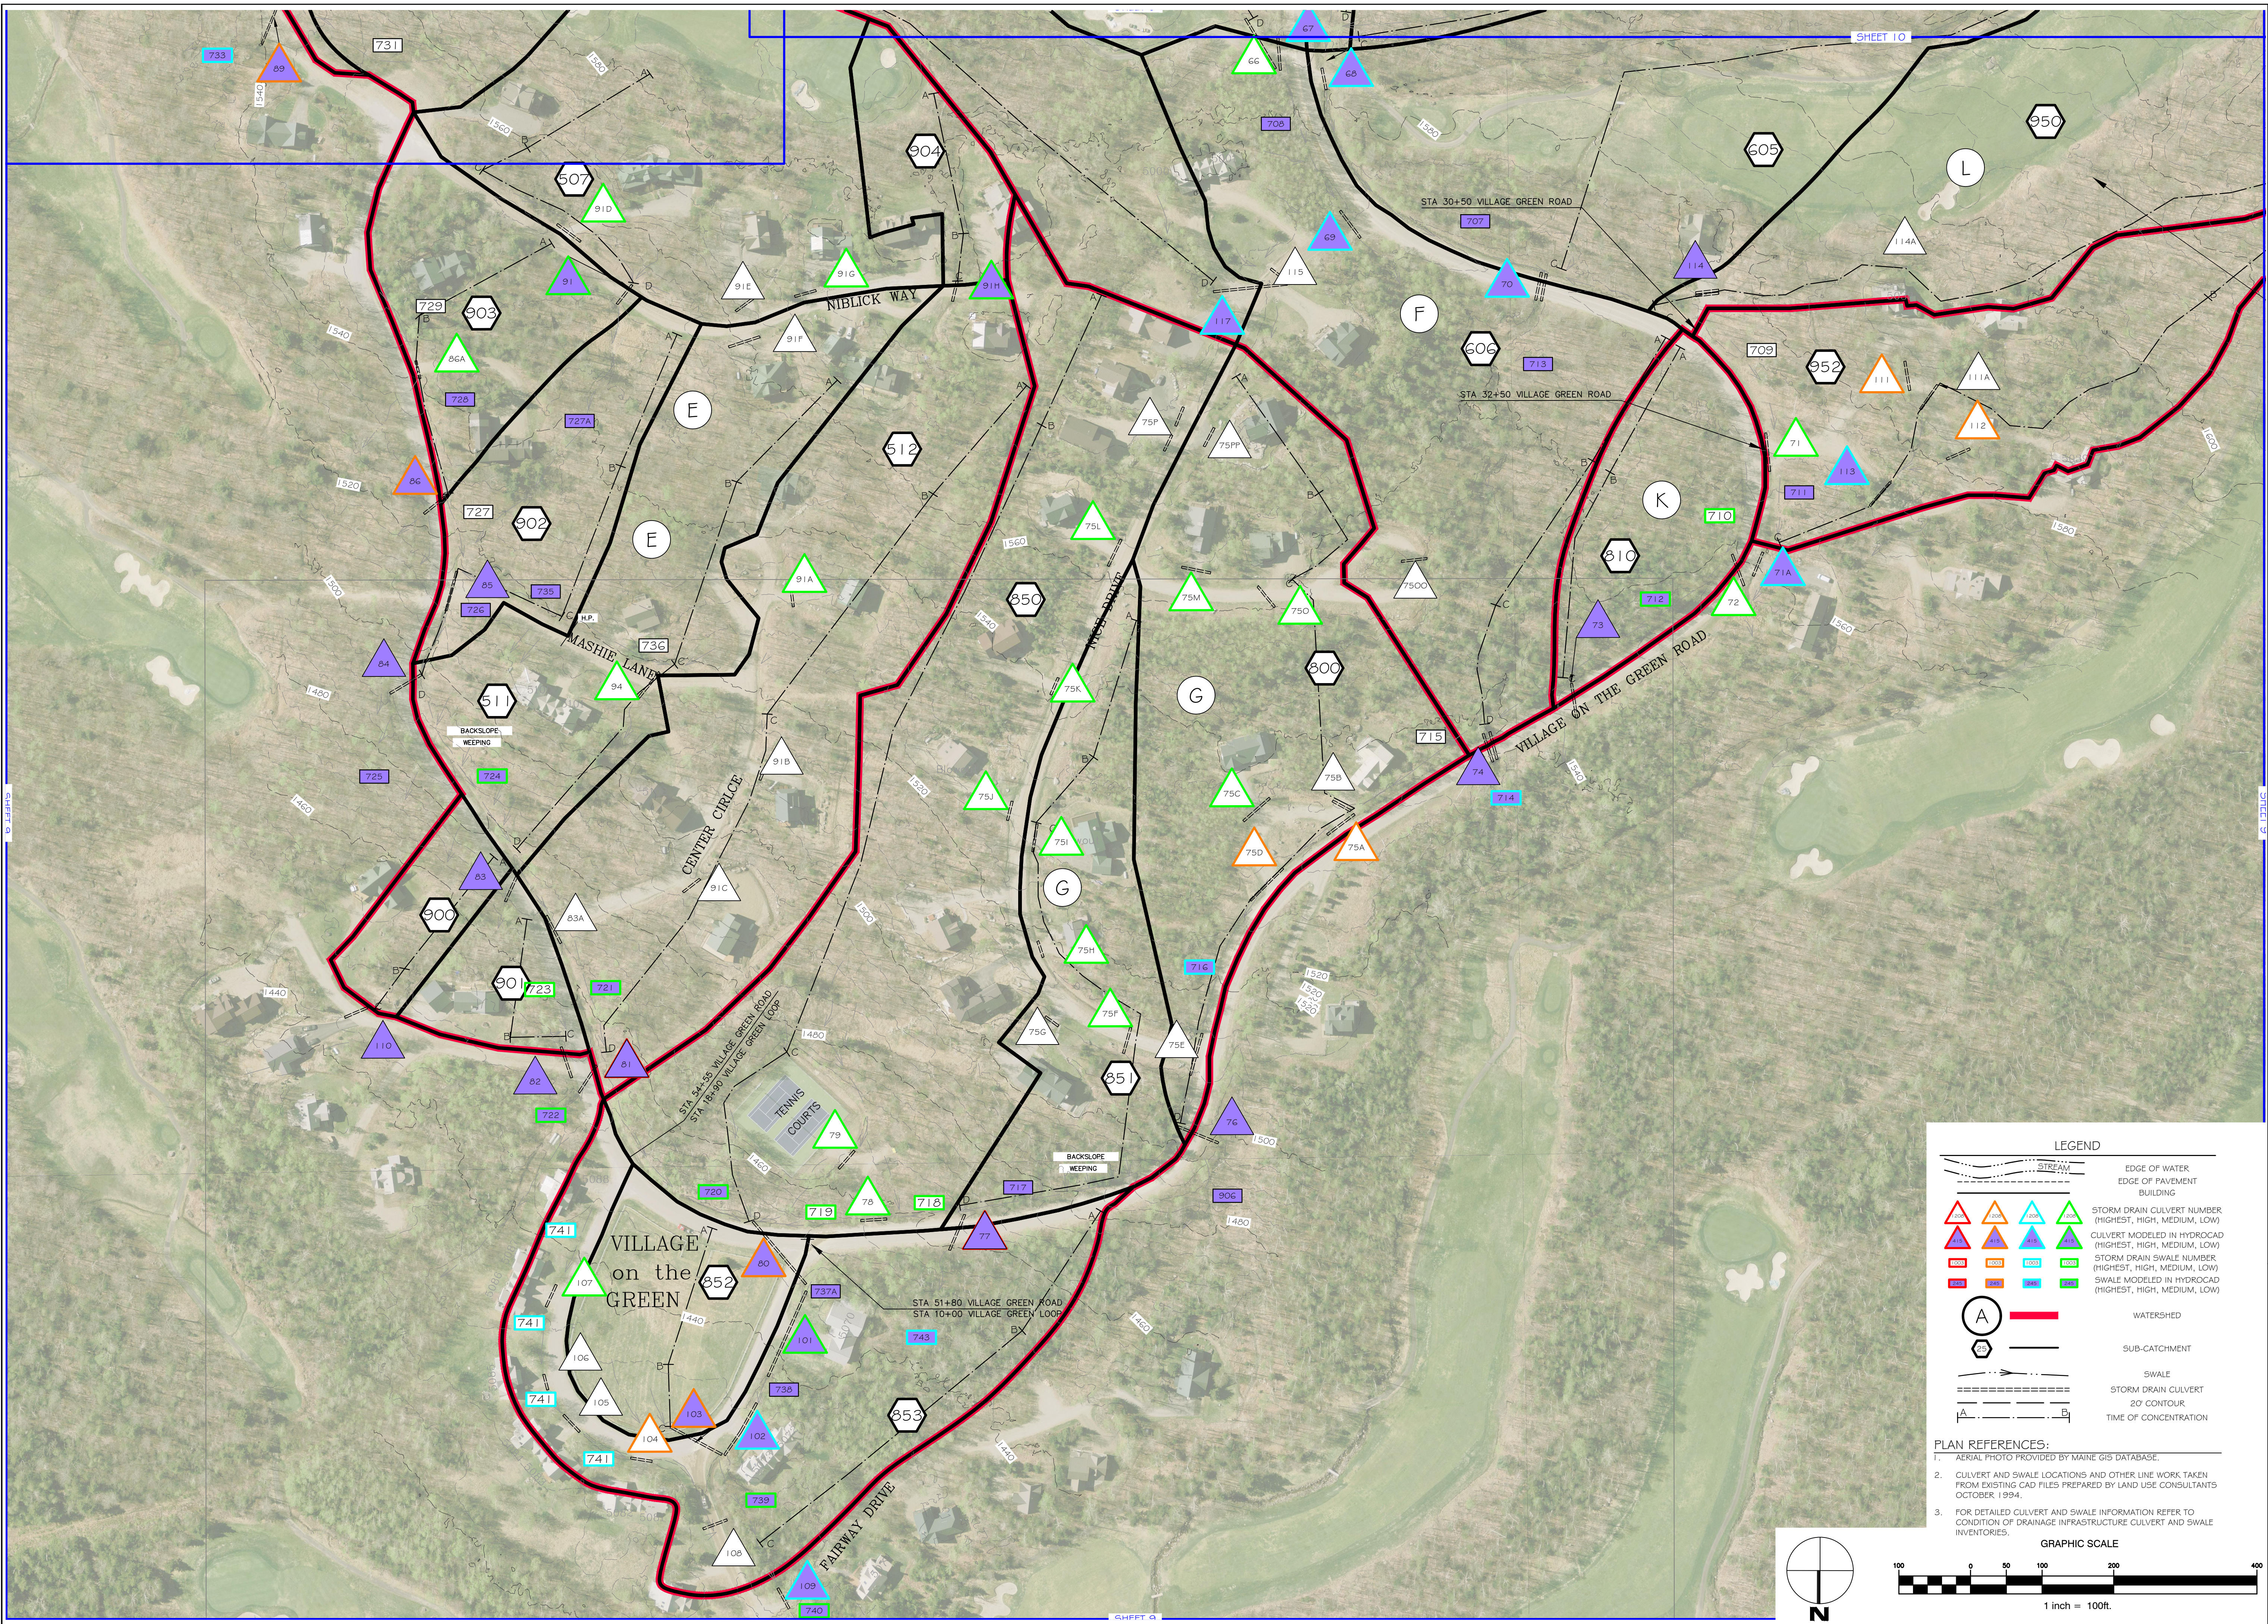

LEGEND

- EDGE OF WATER
- EDGE OF PAVEMENT
- BUILDING
- STORM DRAIN CULVERT NUMBER (HIGHEST, HIGH, MEDIUM, LOW)
- CULVERT MODELED IN HYDROCAD (HIGHEST, HIGH, MEDIUM, LOW)
- STORM DRAIN SWALE NUMBER (HIGHEST, HIGH, MEDIUM, LOW)
- SWALE MODELED IN HYDROCAD (HIGHEST, HIGH, MEDIUM, LOW)
- WATERSHED
- SUB-CATCHMENT
- SWALE
- STORM DRAIN CULVERT
- 20' CONTOUR
- TIME OF CONCENTRATION

- PLAN REFERENCES:**
- AERIAL PHOTO PROVIDED BY MAINE GIS DATABASE.
 - CULVERT AND SWALE LOCATIONS AND OTHER LINE WORK TAKEN FROM EXISTING CAD FILES PREPARED BY LAND USE CONSULTANTS OCTOBER 1994.
 - FOR DETAILED CULVERT AND SWALE INFORMATION REFER TO CONDITION OF DRAINAGE INFRASTRUCTURE CULVERT AND SWALE INVENTORIES.

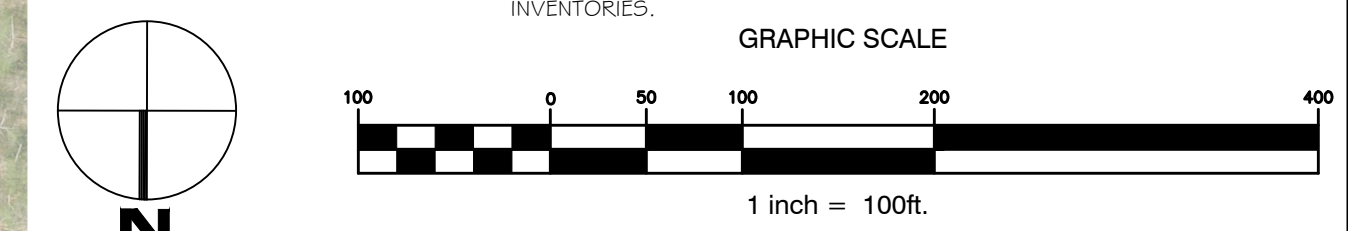

Rev.	Date	Description	Drawn	Check
1	1/13/15	ISSUED TO TOWN	AA/NGC	WRW
2	01/17	ISSUED TO TOWN	TPJ/CAR	WRW
3	1/19/15	ISSUED TO TOWN	JWG	WRW

Sheet Title:
DRAINAGE PLAN SHEET 9

Job No.:	160DRN	Sheet No.:	9
Date:	1-13-2015	Scale:	1"=100'
Drawn:	TPJ	Checked:	WRW

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