


**LEGEND**


STREAM  
 EDGE OF WATER  
 EDGE OF PAVEMENT  
 BUILDING

STORM DRAIN CULVERT NUMBER (HIGHEST, HIGH, MEDIUM, LOW)  
 CULVERT MODELED IN HYDROCAD (HIGHEST, HIGH, MEDIUM, LOW)  
 STORM DRAIN SWALE NUMBER (HIGHEST, HIGH, MEDIUM, LOW)  
 SWALE MODELED IN HYDROCAD (HIGHEST, HIGH, MEDIUM, LOW)

WATERSHED  
 SUB-CATCHMENT  
 SWALE  
 STORM DRAIN CULVERT  
 20' CONTOUR  
 TIME OF CONCENTRATION

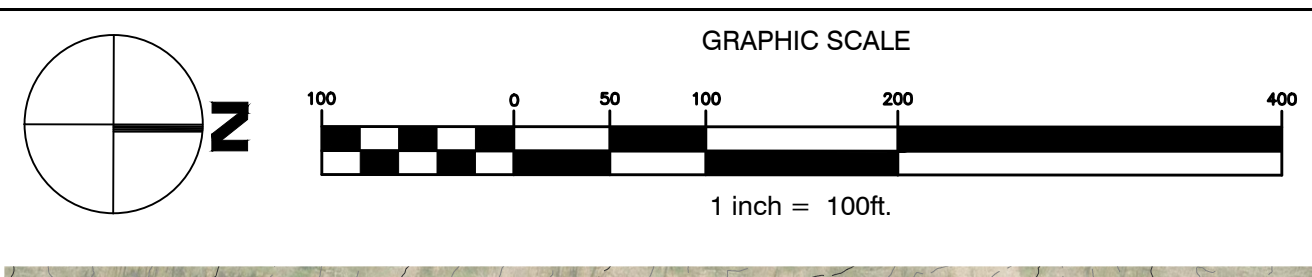

- PLAN REFERENCES:**
1. AERIAL PHOTO PROVIDED BY MAINE GIS DATABASE.
  2. CULVERT AND SWALE LOCATIONS AND OTHER LINE WORK TAKEN FROM EXISTING CAD FILES PREPARED BY LAND USE CONSULTANTS OCTOBER, 1994.
  3. FOR DETAILED CULVERT AND SWALE INFORMATION REFER TO CONDITION OF DRAINAGE INFRASTRUCTURE CULVERT AND SWALE INVENTORIES.

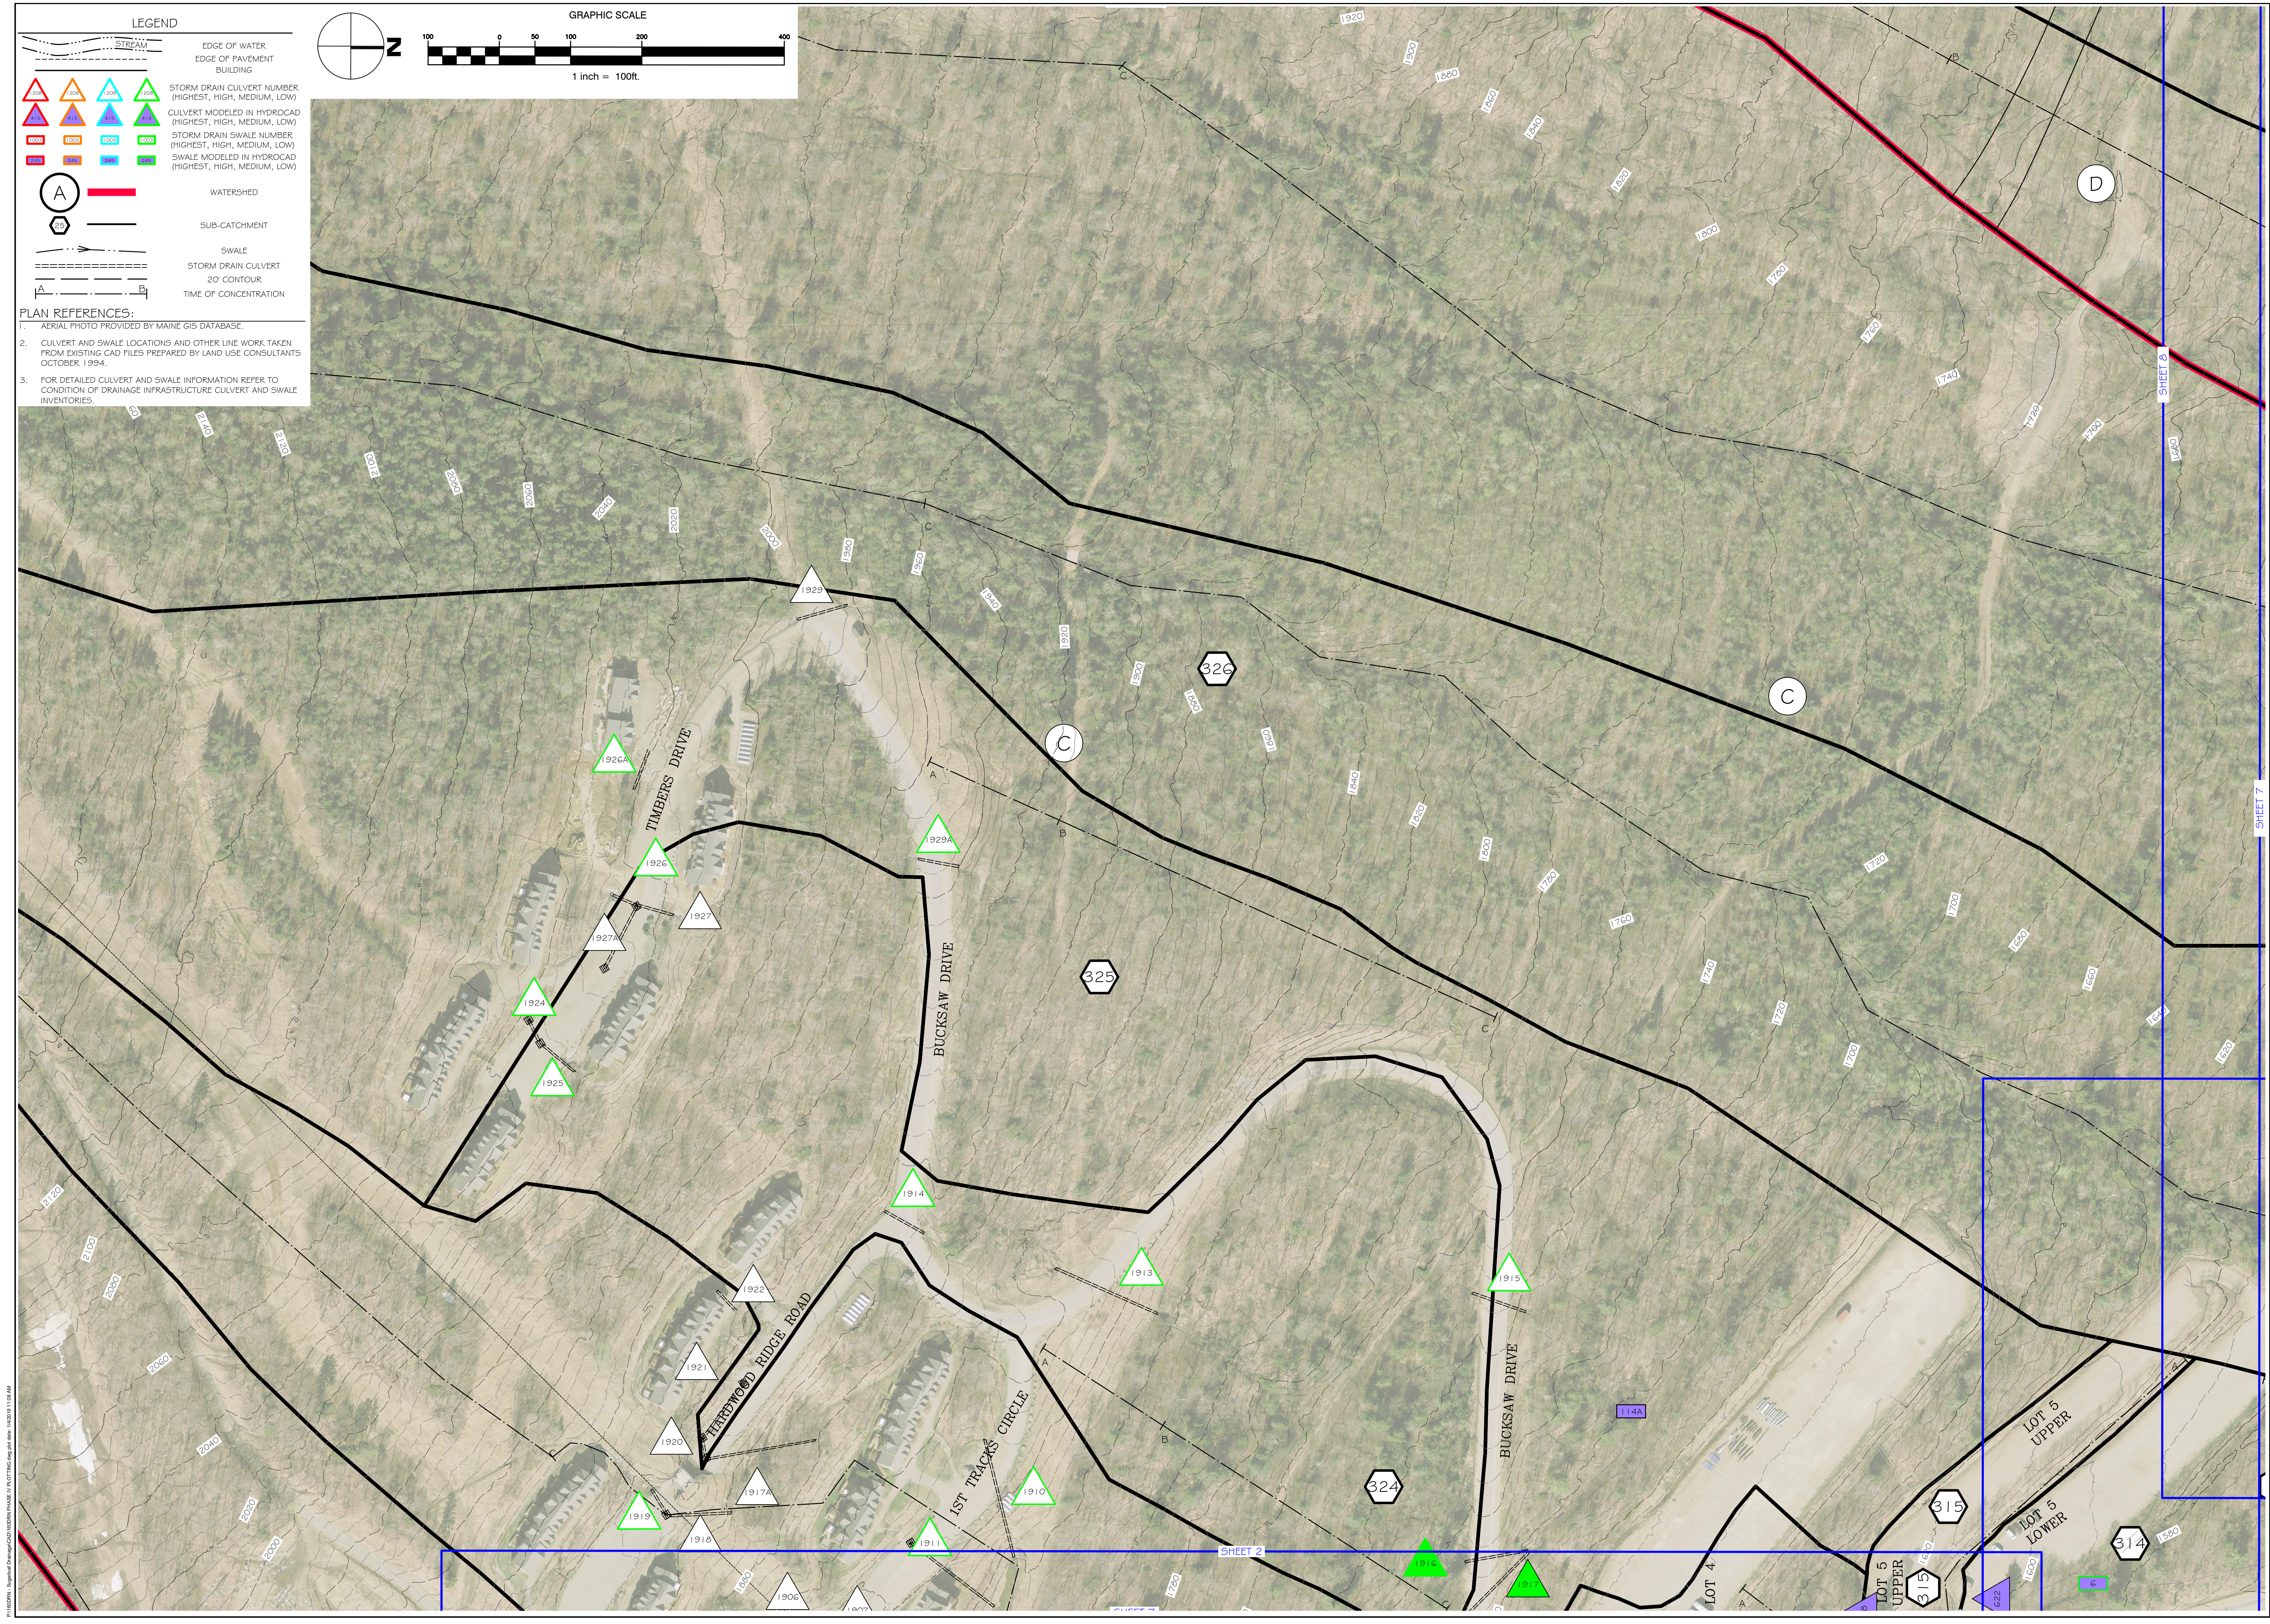

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**SUGARLOAF MOUNTAIN WATERSHED ANALYSIS**  
PHASE IV  
CARRABASSETT VALLEY, MAINE

**TOWN OF CARRABASSETT VALLEY**  
101 CARRIAGE ROAD  
CARRABASSETT VALLEY, ME 04947

Rev.	Date	Description	Drawn	Check
1	1/13/15	ISSUED TO TOWN	AA/NGC	WRW
2	6/1/17	ISSUED TO TOWN	TPJ/CAR	WRW
3	1/6/19	ISSUED TO TOWN	JWG	WRW

Sheet Title:  
**DRAINAGE PLAN SHEET 7**

Job No.: 160DRN Sheet No.: **7**

Date: 1-13-2015  
Scale: 1"=100'  
Drawn: TPJ  
Checked: WRW