

SUGARLOAF MOUNTAIN WATERSHED ANALYSIS

PHASE IV
CARRABASSETT VALLEY, MAINE

TOWN OF CARRABASSETT VALLEY


101 CARRIAGE ROAD
CARRABASSETT VALLEY, ME 04947

Rev.	Date	Description	Drawn	Check
1	1/13/15	ISSUED TO TOWN	AAN/GC	WRW
2	6/11/17	ISSUED TO TOWN	TPJ/CAR	WRW
3	1/6/19	ISSUED TO TOWN	JWG	WRW

Sheet Title:
**DRAINAGE PLAN
SHEET 6**

Job No.:	160DRN	Sheet No.:	
Date:	1-13-2015	Scale:	1"=100'
Drawn:	TPJ	Checked:	WRW


6

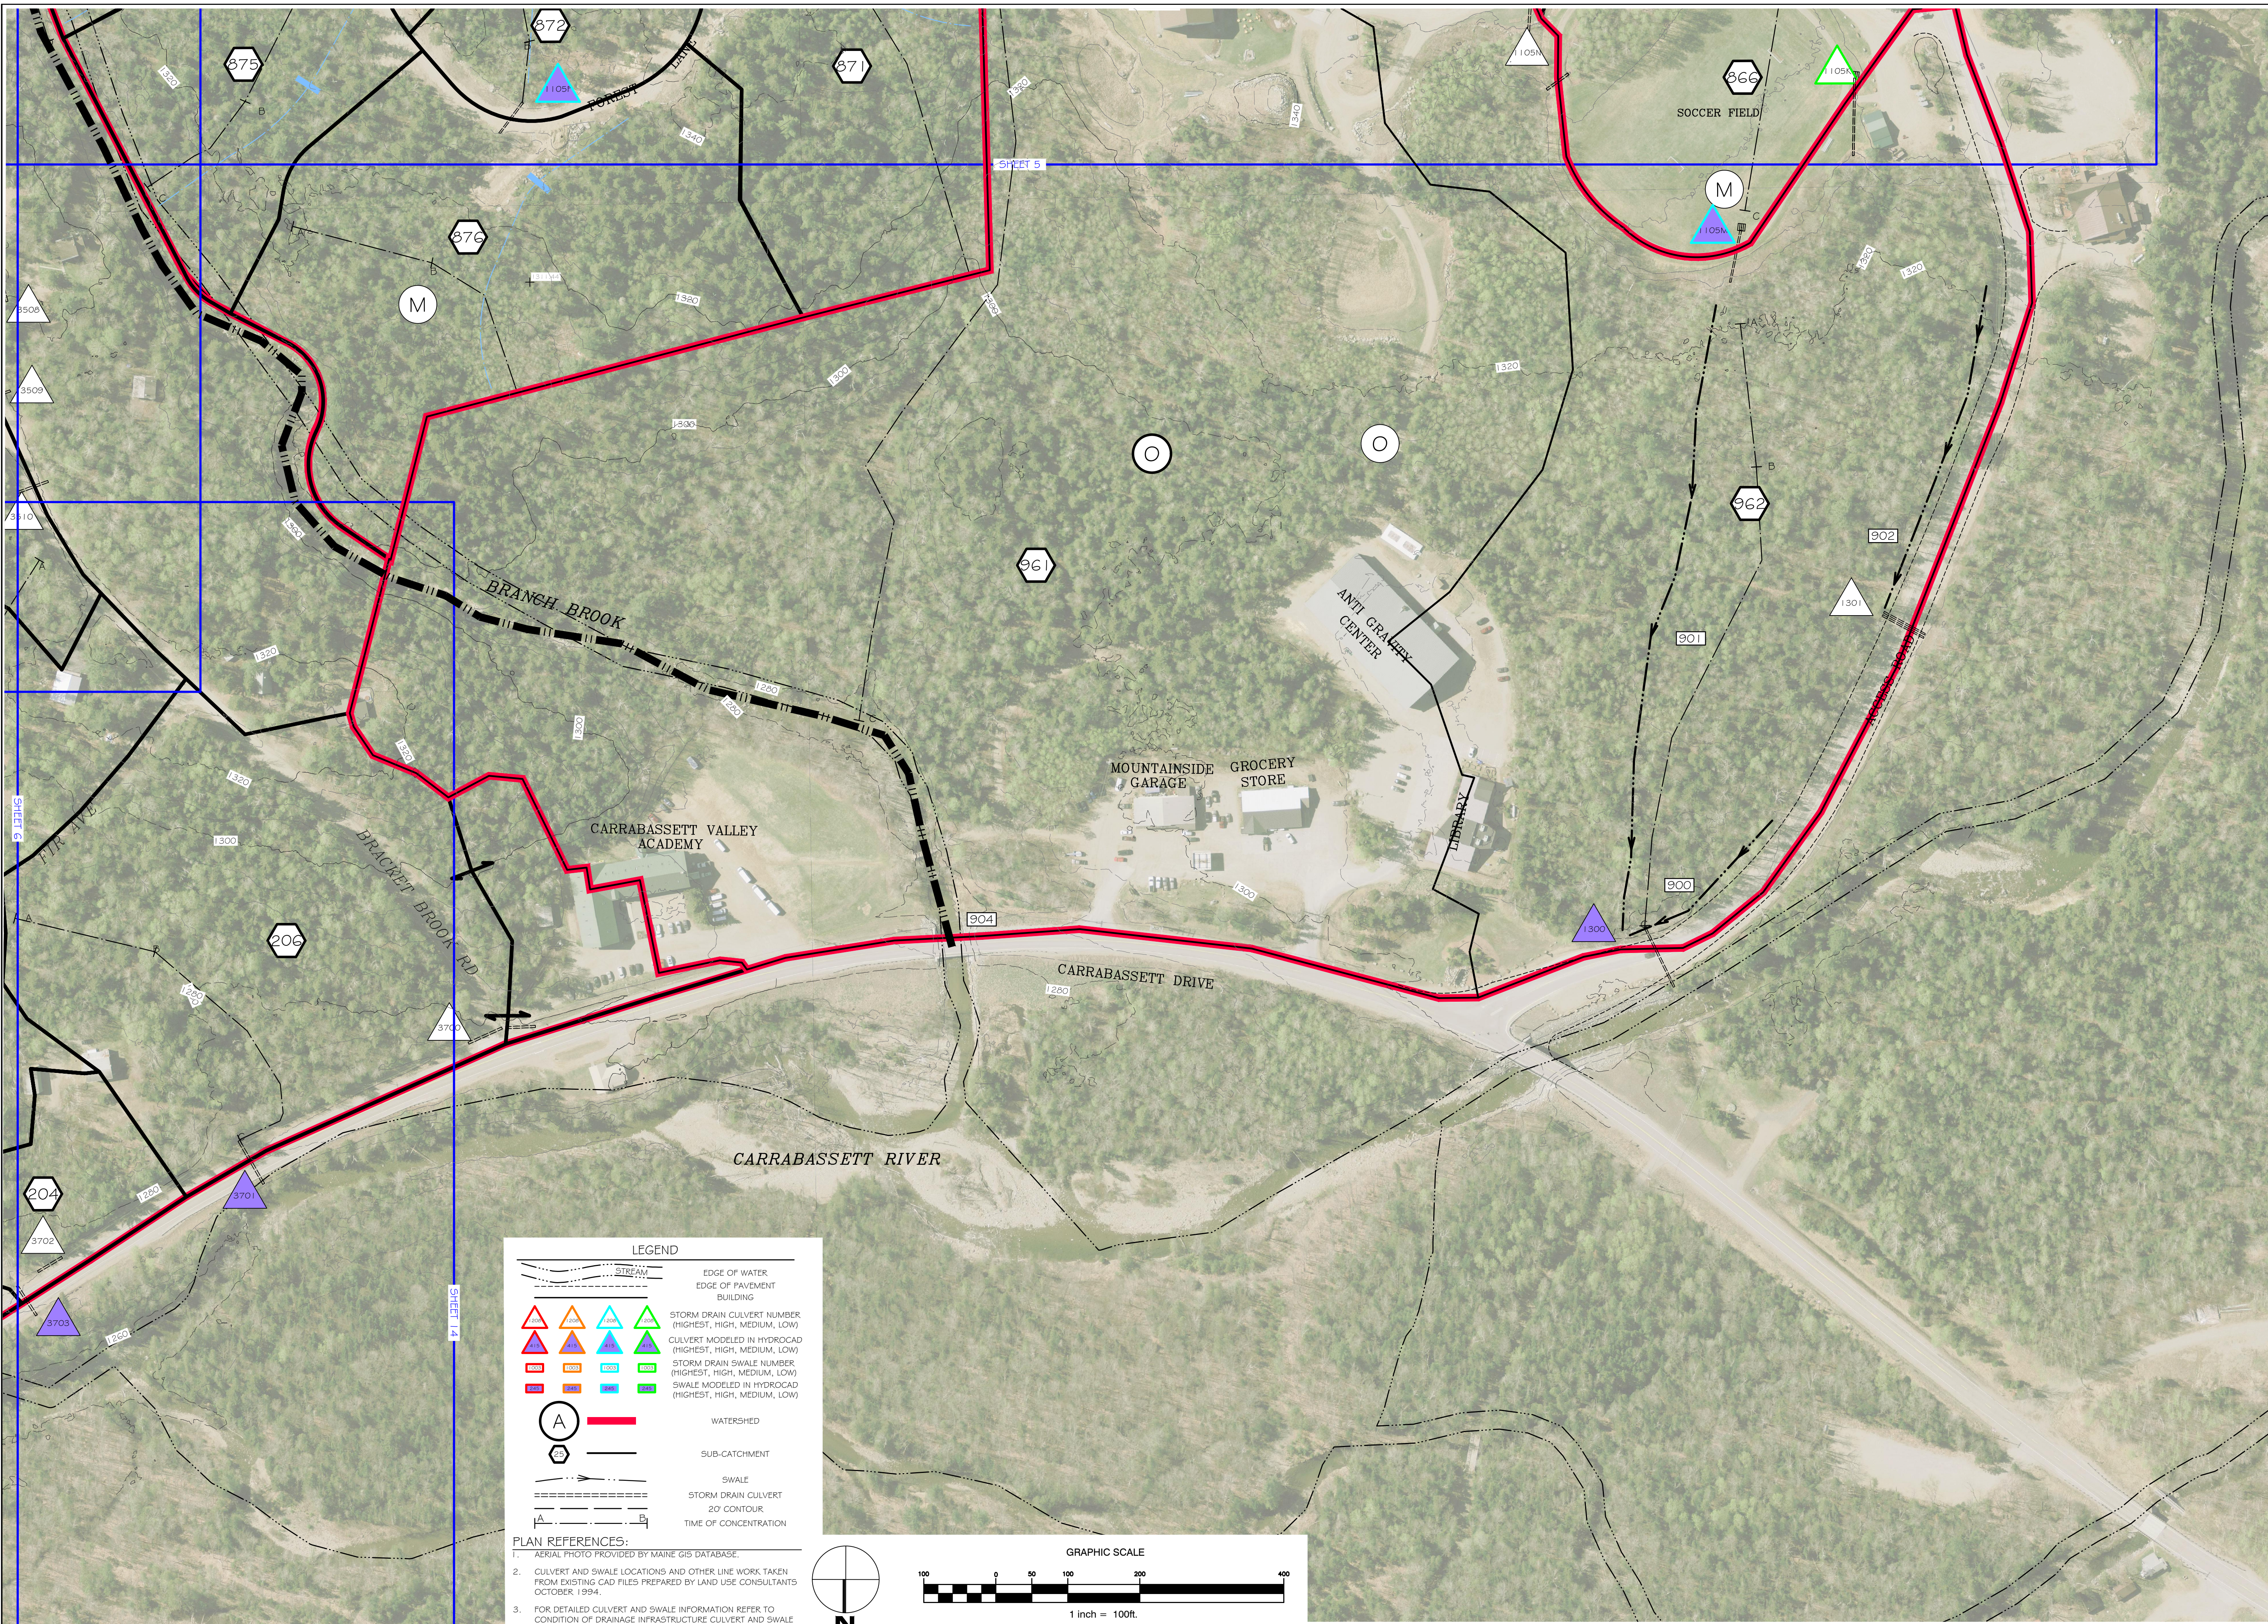

LEGEND

	STREAM	EDGE OF WATER
	EDGE OF PAVEMENT	
	BUILDING	
	STORM DRAIN CULVERT NUMBER (HIGHEST, HIGH, MEDIUM, LOW)	
	CULVERT MODELED IN HYDROCAD (HIGHEST, HIGH, MEDIUM, LOW)	
	STORM DRAIN SWALE NUMBER (HIGHEST, HIGH, MEDIUM, LOW)	
	SWALE MODELED IN HYDROCAD (HIGHEST, HIGH, MEDIUM, LOW)	
	WATERSHED	
	SUB-CATCHMENT	
	SWALE	
	STORM DRAIN CULVERT	
	20' CONTOUR	
	TIME OF CONCENTRATION	

- PLAN REFERENCES:**
- AERIAL PHOTO PROVIDED BY MAINE GIS DATABASE.
 - CULVERT AND SWALE LOCATIONS AND OTHER LINE WORK TAKEN FROM EXISTING CAD FILES PREPARED BY LAND USE CONSULTANTS OCTOBER 1994.
 - FOR DETAILED CULVERT AND SWALE INFORMATION REFER TO CONDITION OF DRAINAGE INFRASTRUCTURE CULVERT AND SWALE INVENTORIES.

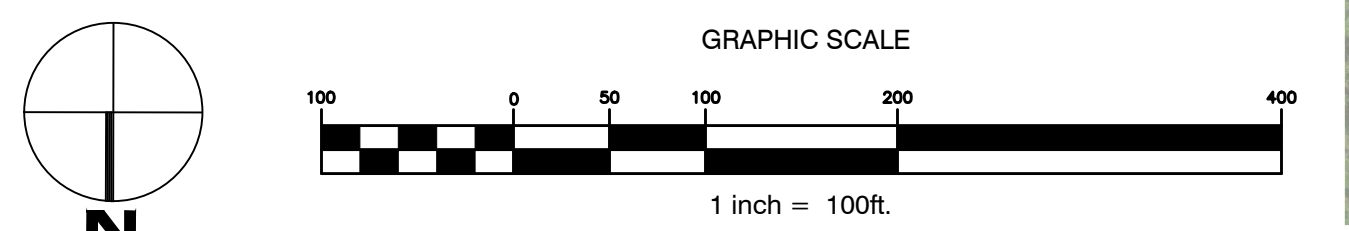

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